




D01 Single Leaf Gate Front Elevation A-A1
Scale: 1:20

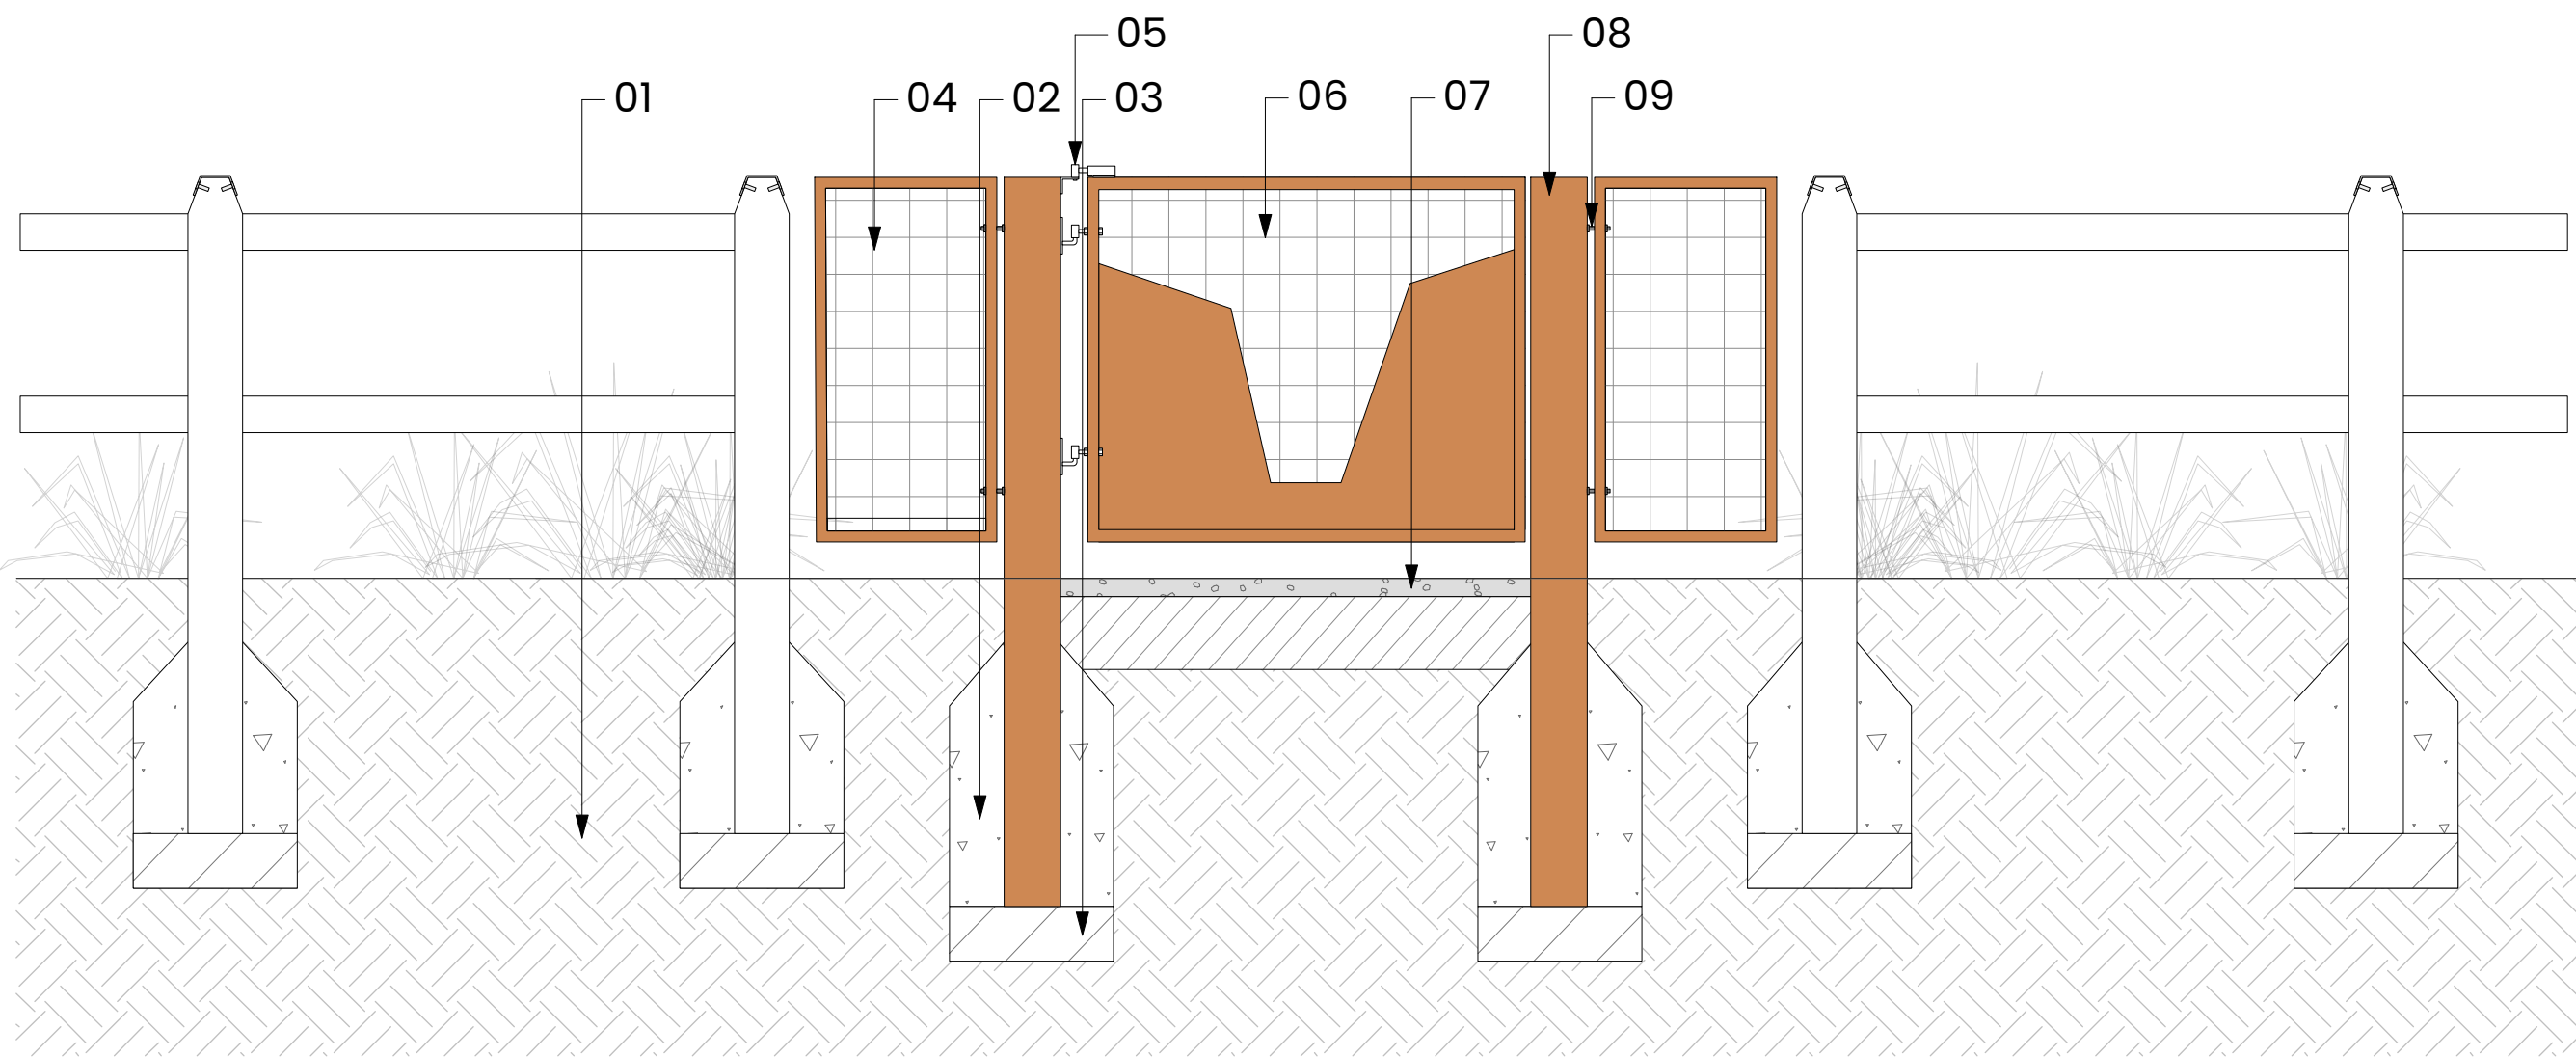

D02 Single Leaf Gate Rear Elevation B-B1
Scale: 1:20

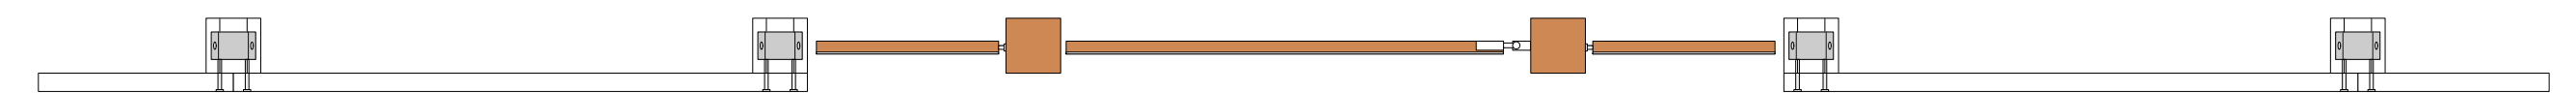

D03 Single Leaf Gate Plan
Scale: 1:20

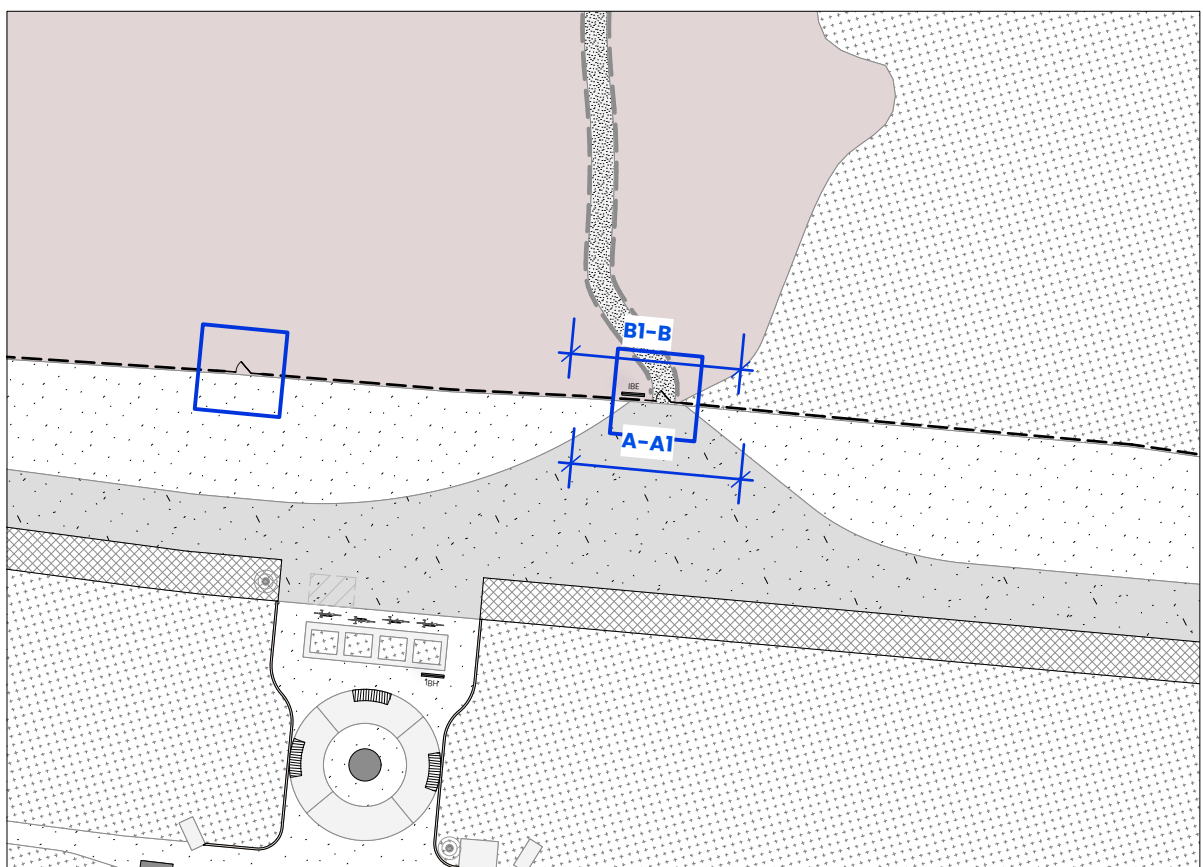

D04 Single Leaf Gate - Location
Scale: 1:500

NOTES:
1. DO NOT SCALE FROM THIS DRAWING. ALWAYS WORK TO NOTED DIMENSIONS.
2. ALL SETTING-OUT LEVELS AND DIMENSIONS TO BE CHECKED ON SITE PRIOR TO THE INSTALLATION OF MATERIALS AND ANY DISCREPANCIES ARE TO BE BROUGHT TO THE ATTENTION OF THE CONTRACT ADMINISTRATOR IMMEDIATELY.
3. THIS DRAWING MUST BE READ WITH THE RELEVANT SPECIFICATION DOCUMENTS AND DETAIL DRAWINGS. ANY DISCREPANCIES MUST BE BROUGHT TO THE ATTENTION OF THE CONTRACT ADMINISTRATOR IMMEDIATELY.
4. THIS DRAWING IS COPYRIGHT PROTECTED AND MAY NOT BE REPRODUCED IN WHOLE OR PART WITHOUT WRITTEN AUTHORITY.
5. ALL DIMENSIONS ARE IN MILLIMETRES UNLESS OTHERWISE STATED.
6. NOTE DRAWING SUSTAINABILITY CODE SHOWN BELOW. DRAWING NOT TO BE USED FOR CONTRACTUAL AGREEMENT WITHOUT A1 STATUS.

THIS DRAWING WAS PLOTTED ON:
14/08/2025

REVISION HISTORY				
DATE	REV	ZONE	DESCRIPTION	CHK
05/08/2025	P01		Draft Issue	CE
14/08/25	P02		Stage 4 issue	MDM

- KEY**
- EXISTING GROUND CONDITIONS
 - SUB BASE- TO ENGINEER'S DETAIL AND SPEC
 - CONCRETE FOUNDATION - TO ENGINEER'S DETAIL AND SPECS
 - GATE SIDE PANEL - CORTEN BOX SECTION WITH CORTEN WELD MESH INFILL - STRUCTURAL ELEMENTS TO ENGINEER - SUBJECT TO FABRICATOR DETAIL - SPEC CLAUSE Q50/120.2
 - SELF SOFT CLOSE HINGES - SPEC CLAUSE Q50/120.2
 - GATE - CORTEN BOX SECTION WITH CORTEN WELD MESH INFILL & SHEET CORTEN PANEL - STRUCTURAL ELEMENTS TO ENGINEER - SUBJECT TO FABRICATOR DETAIL - SPEC CLAUSE Q50/120.2
 - S1.0 STONE TO DUST SURFACE - REFER TO DRAWING NO. 6000
 - CORTEN BOX SECTION POSTS 150 x 150 x 2000mm - STRUCTURAL ELEMENTS TO ENGINEER - SUBJECT TO FABRICATOR DETAIL - SPEC CLAUSE Q50/120.2
 - FIXING BOLTS - TO ENGINEER'S DETAIL AND SPECS

NOTE
SUBJECT TO ENGINEER REVIEW / COMMENT

NOTE
DESIGN INTENT - FINAL DIMS TO MANUFACTURER DETAIL



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Client
Cumberland Council

Project
The Iron Line
Millom, Cumbria

Drawing Title
D | Single Leaf Gate Detail

Created By	Checked By	Scale	Sheet Size
CE	CL	As Noted	A1
Project Number	Originator	Volume	Level
289	LYR	XX-ZZ-DWG-L-6009	
Work Stage	Status	Revision	
Stage 4	S4	P02	