
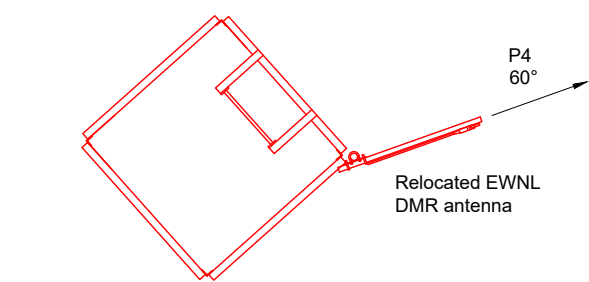



Proposed North East Elevation

Scale 1:125

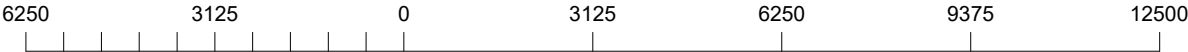


Plan on Tower @ 23.0m

Scale 1:50

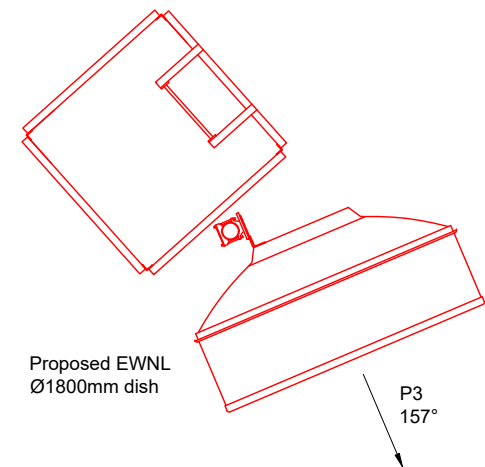


Plan on Tower @ 22.1m

Scale 1:50

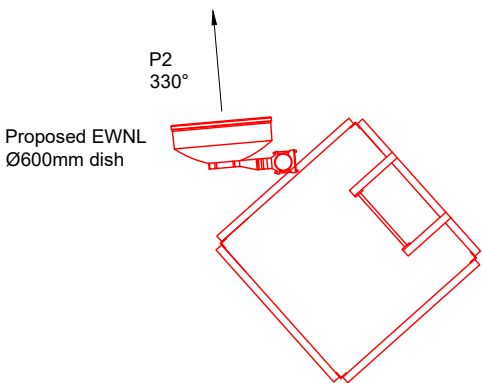

Plan on Tower @ 20.0m

Scale 1:50

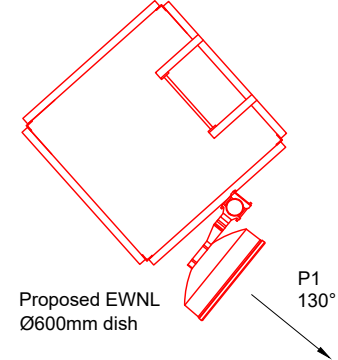

Plan on Tower @ 15.6m

Scale 1:50

- Notes:
1. This drawing to be read in conjunction with full drawing series
  2. All dimensions are in mm unless otherwise noted.

Proposed Equipment Schedule						
Ref.	Dish Type	Size (mm)	Height A.G.L.(m)	Antenna Bearing	Cable Type	Cable Length (m)
P1	Parabolic	600	15.6	130°	TBC	TBC
P2	Parabolic	600	20.0	355°	TBC	TBC
P3	Parabolic	1800	22.1	157°	TBC	TBC
P4	DMR	TBC	23.0	60°	TBC	TBC

REV.	DESCRIPTION	DATE	BY
C	PROPOSED EQUIPMENT AMENDED	13.02.25	CK
B	PROPOSED EQUIPMENT ADDED	03.09.24	CK
A	GENERAL ARRANGEMENT ISSUE	15.08.24	RFS



Client



Drawing Title  
PROPOSED SITE ELEVATION

Site Location  
MIDWAY PRIMARY SUBSTATION  
GOSFORD ROAD (B5344)  
CUMBRIA  
CA20 1FB

Drawn by CK	Checked by SB	Approved by RW
Date Drawn 13.02.25	Date Checked 13.02.25	Date Approved 13.02.25

Drawing Number  
P2407\_003-GA-005-C