


Please Note:
 Drawing subject to relevant statutory approvals.
 All dimensions to be checked on site. Do not scale from this drawing. Work to a signed dimensioning copy.
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Material Key (Elab):

	Internal Studwork
	Internal Studwork with 60mm mineral wool to cavity.
	Blockwork
	Facing Brick
	Existing Walls
	Thermable proprietary vertical has rated dpc
	SFR Soil and Vent Pipe
	AVV Air Admittance Valve
	BIG Back Inlet Gully
	Head detector linked to matrix with battery back-up.
	Smoke detector linked to matrix with battery back-up.
	Carbon Monoxide Detector
	Water Radiator
	Wc/Hinged Toilet Rail
	Mechanised extract
	Boiler Flue
	Electric Socket (Number denotes Single/Double / H1 = High Level / UW = Under worktop)
	Coffee Control unit with 2-pole switch
	Light Switch - (Number denotes gang = D = Extended) - New low energy downlighter + hood
	New moisture resistant downlighter + hood
	Flood Spur
	32 Amp Consumer Switch
	Pendant Light Fitting
	PRF Fitting
	Wall Mounted Bulkhead Light Fitting
	IP65 Dimmable/Froconcent Light Fitting 800mm long
	External Water Tap
	External Electric Socket (Number denotes gang = D = Extended)
	Mirror Light Feed
	Alarm Panel / Alarm Key Pad
	Thermostat
	Spk TV / BT Phone Connection Points
	IP54 Dimmable/Froconcent Light Fitting 800mm long
	Electric Data Board
	Under Floor Heating Manifold
	Mains wound door bell
	Shaver socket

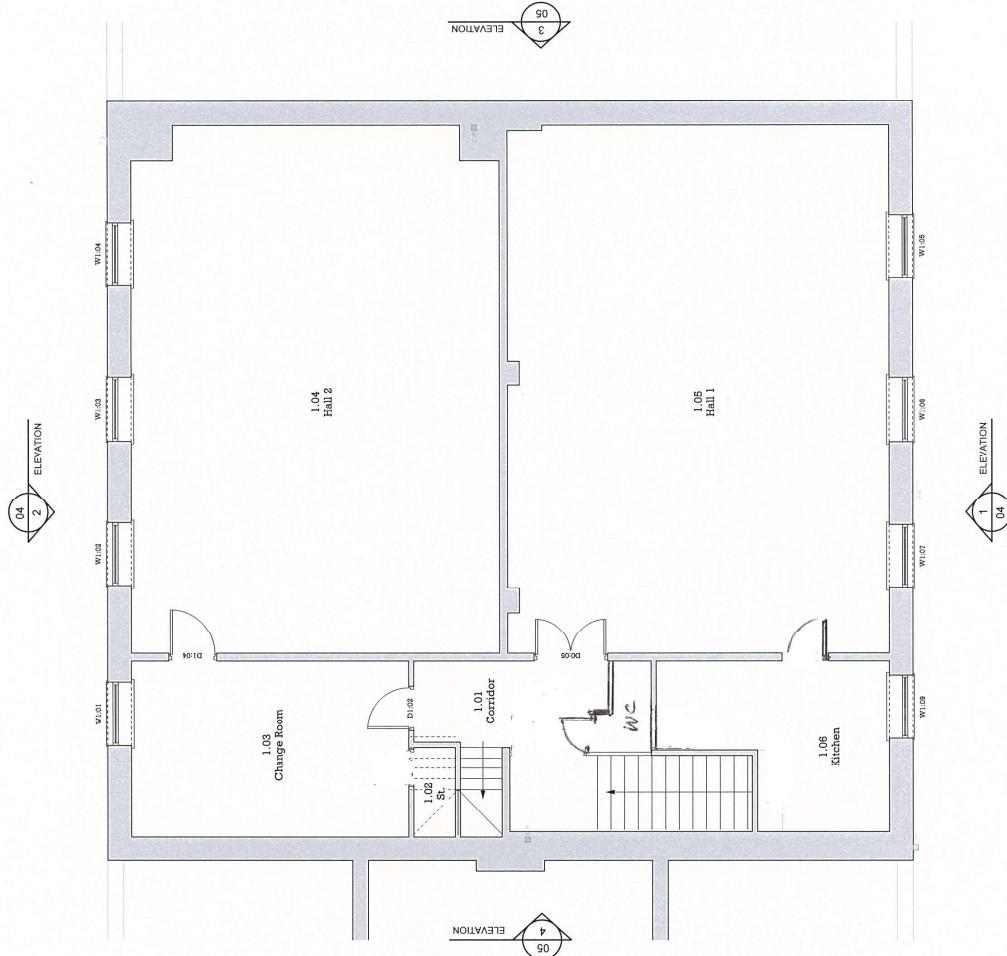

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MC Architecture + Design

Preliminary Tender
 For Approval Construction

Project >
 Sawfall Hall, Thirlestane Street, Seaside,
 Cumbria, CA20 1QF.

Drawing Title >
 Existing First Floor Plan.

Scale >

1:50 @ A1

Drawing No >

1718-002-003

Rev >

A

1 PLAN - EXISTING AND PROPOSED 1ST FLOOR

SCALE 1:50 @ A1