

1. **General Notes:**
- 1.1. Do not scale from this drawing.
 - 1.2. All dimensions in millimetres unless stated otherwise.
 - 1.3. This drawing is to be read in conjunction with all drawings and the specification.


PROPOSED ANTENNA DETAILS						
Item	Type	Reference	Height (m)			Approx Length
			Base	Mid	Top	
D1	Dish	0.8 10.5 GHz	6.0	6.0	90°	TBC
D2	Dish	0.8 10.5 GHz	6.0	6.0	320°	TBC

Cable allowance should be added for internal route to equipment rack

ALL CABLES ARE TO BE CONFIRMED AT DETAIL DESIGN STAGE


Building Roof Plan at 6.0m

Scale 1:100

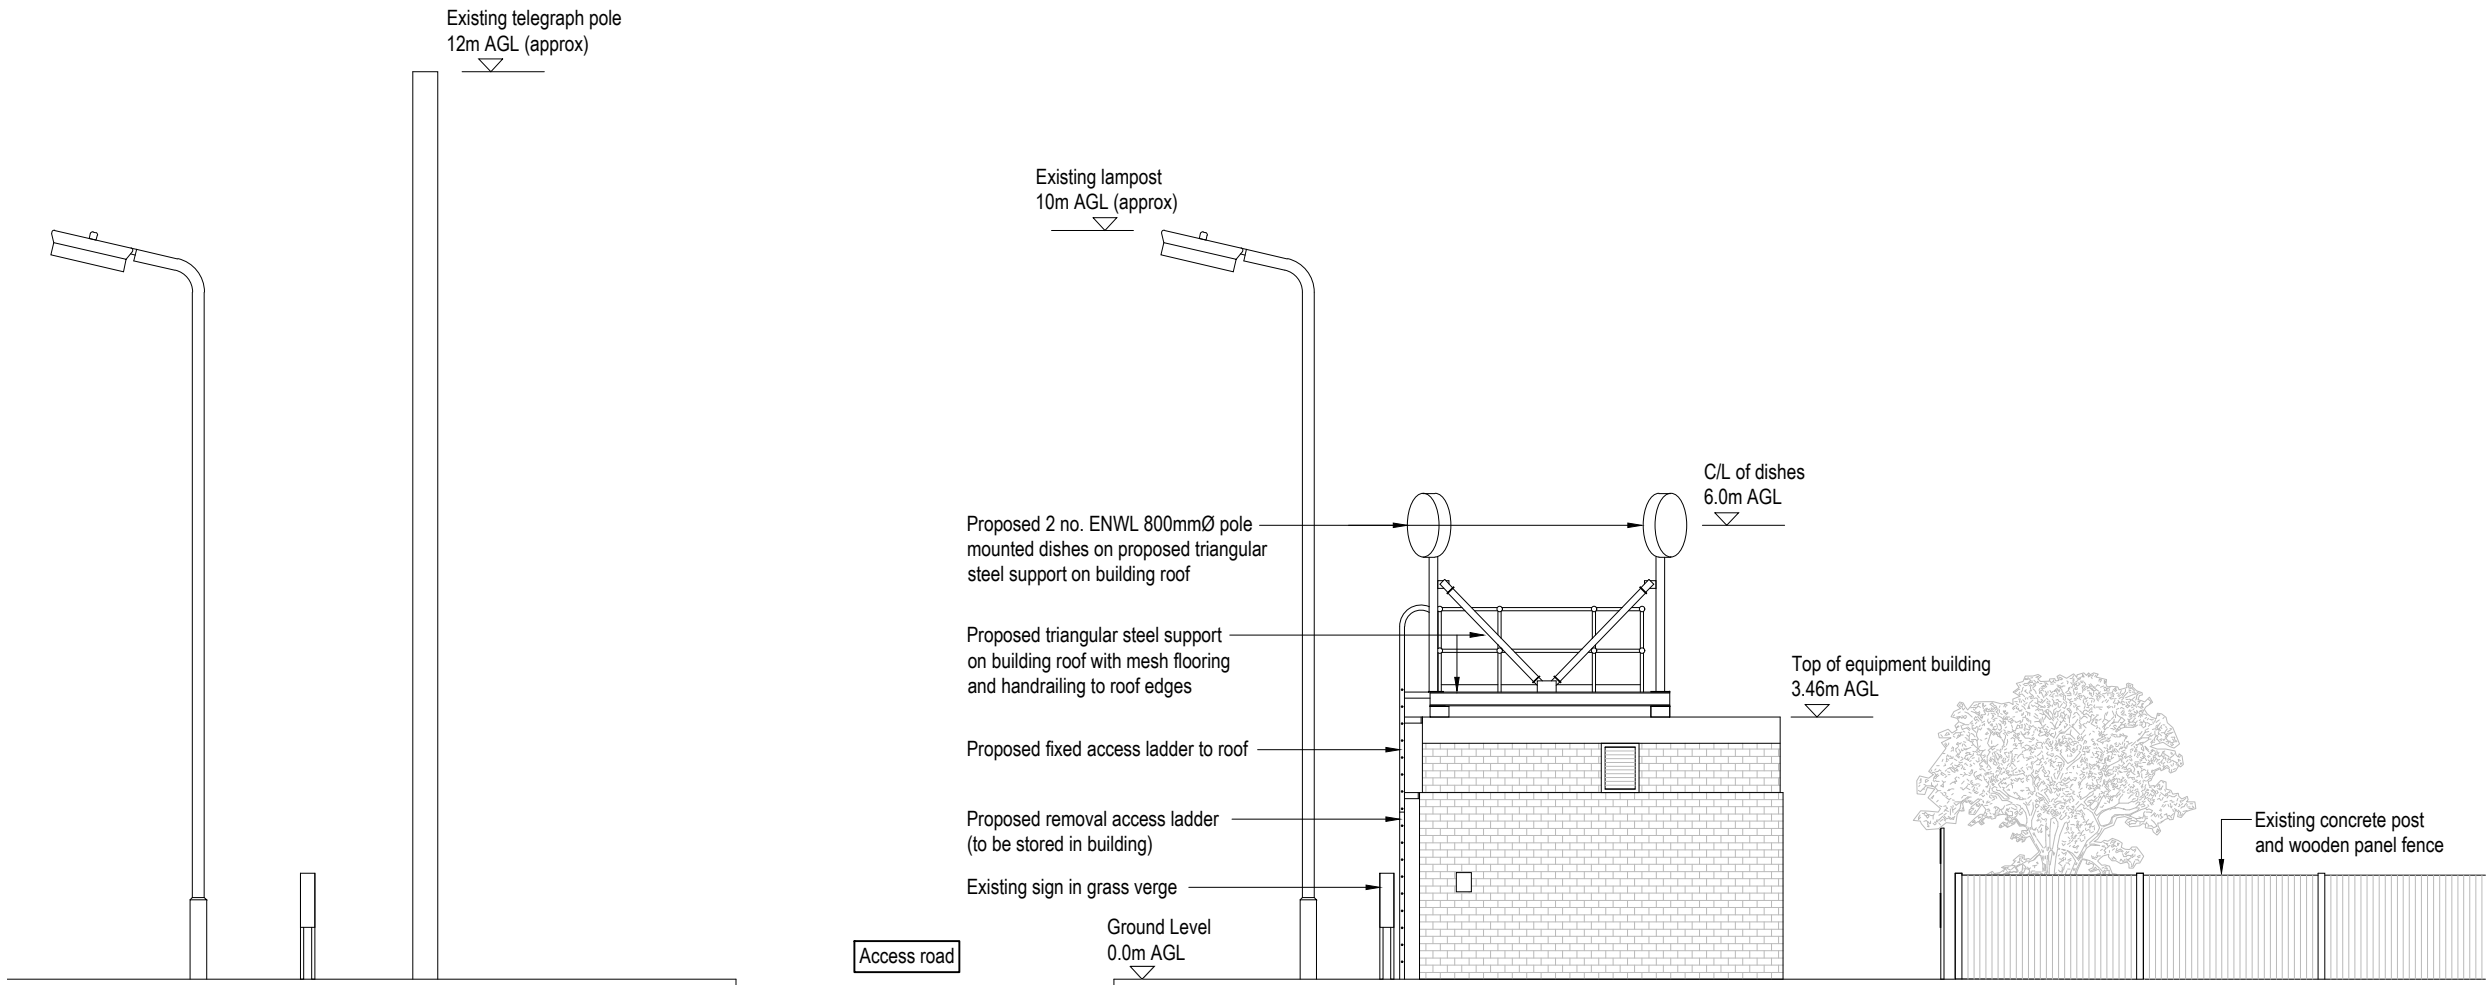

North Elevation

Scale 1:100

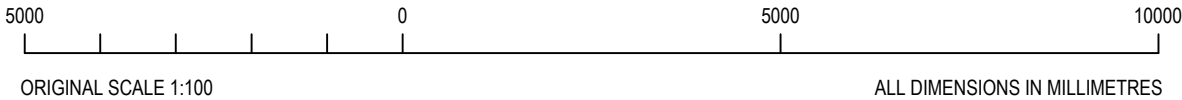

Project
ENWL Transmission Network

Drawing
Haverigg Prison Sub Station
Haverigg Relay station 11kV, North Ln,
Haverigg, Millom, Cumbria LA18 4NA
PLANNING DRAWING No.3

Scale @ A3
As Shown

Drawn
KH

Checked
FA

Approved
NG

Project No.
CS052817-MCT1260

Date
12/01/2022

Drawing Identifier
Project - Originator - Zone - Level - File Type - Role - Number
70551-CAP-00-XX-DR-C-0003

BS1192 Compliant
rev
P02

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