

SCALE 1:20

- All works to be carried out in accordance with the following:-
1. UK water industry research Ltd. 'Civil Engineering Specification for the water Industry, 5th Edition.
 2. Building Regulations Section 'H'
 3. BE EN 752 Drain and Sewers Systems outside buildings.
- Foul Water: Falls in runs - 1:10 max - 1:60 min.
 - All new drainage branches to be swept in direction of flow.
 - All new drainage branches to be fitted with a RE.

- SUDS
- All parking areas are to be constructed with a porous build up on free draining stone.
 - All pods to have a 250mm wide by a min 200mm deep gravel border to both draining sides.

- Surface Water Drainage
- A secondary run will be taken from the front of each unit directly to the soakaway, avoiding the treatment tank.
 - This will allow for any additional surface water to drain directly into the soakaway to avoid any standing water around the units.

KEY TO SYMBOLS

- SURFACE WATER DRAINAGE RUN
- DRAINAGE RUN
- IC INSPECTION CHAMBER
- SC SAMPLE CHAMBER
- WATER TREATMENT PLANT

Date	Description	Rev	By

Revision Description



Project:
Proposed Glamping Site For Gemma Waghorn
5 Ellerbeck Barns, Egremont Road, Egremont Cumbria
CA222UA

Drawing Title:
PROPOSED SURFACE WATER DRAINAGE PLAN

Drawing Number:
210825-01-15

Revision:

Date: 21-03-23

Scale: 1:100 @ A1


Drawn By: -

CAD Dwg File: TA

Checked By:

Issue Status:
Full Planning Application

- OWNERSHIP BOUNDARY
- SITE BOUNDARY

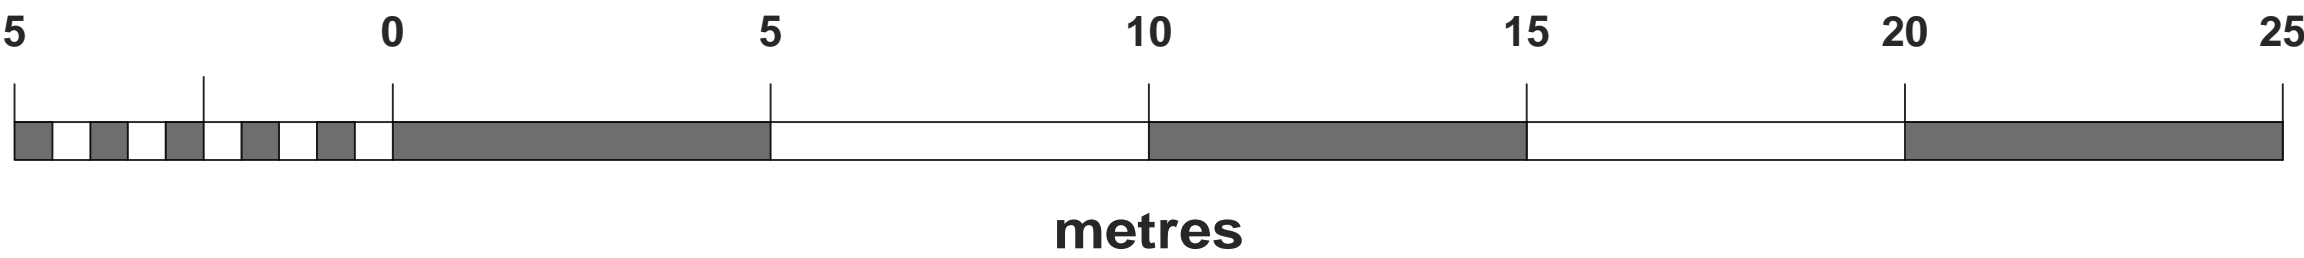

NORTH

